


VICINITY MAP (NOT TO SCALE):

REVISIONS



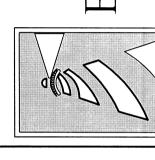





CLIENT INFORMATION: Seagate Landing, LLC Stephen Conway 6252 Towles Road Wilmington, NC 28409 Phone: 910-538-9737

| JAE | SHEET SIZE: | 24x36 |
|-----|-------------|----------------------|
| CDC | DATE: | 8/8/2018 |
| CDC | SCALE: | 1" = 30' |
| R; | 2018-023 | |
| | CDC | CDC DATE: CDC SCALE: |

DRAWING NUMBER:

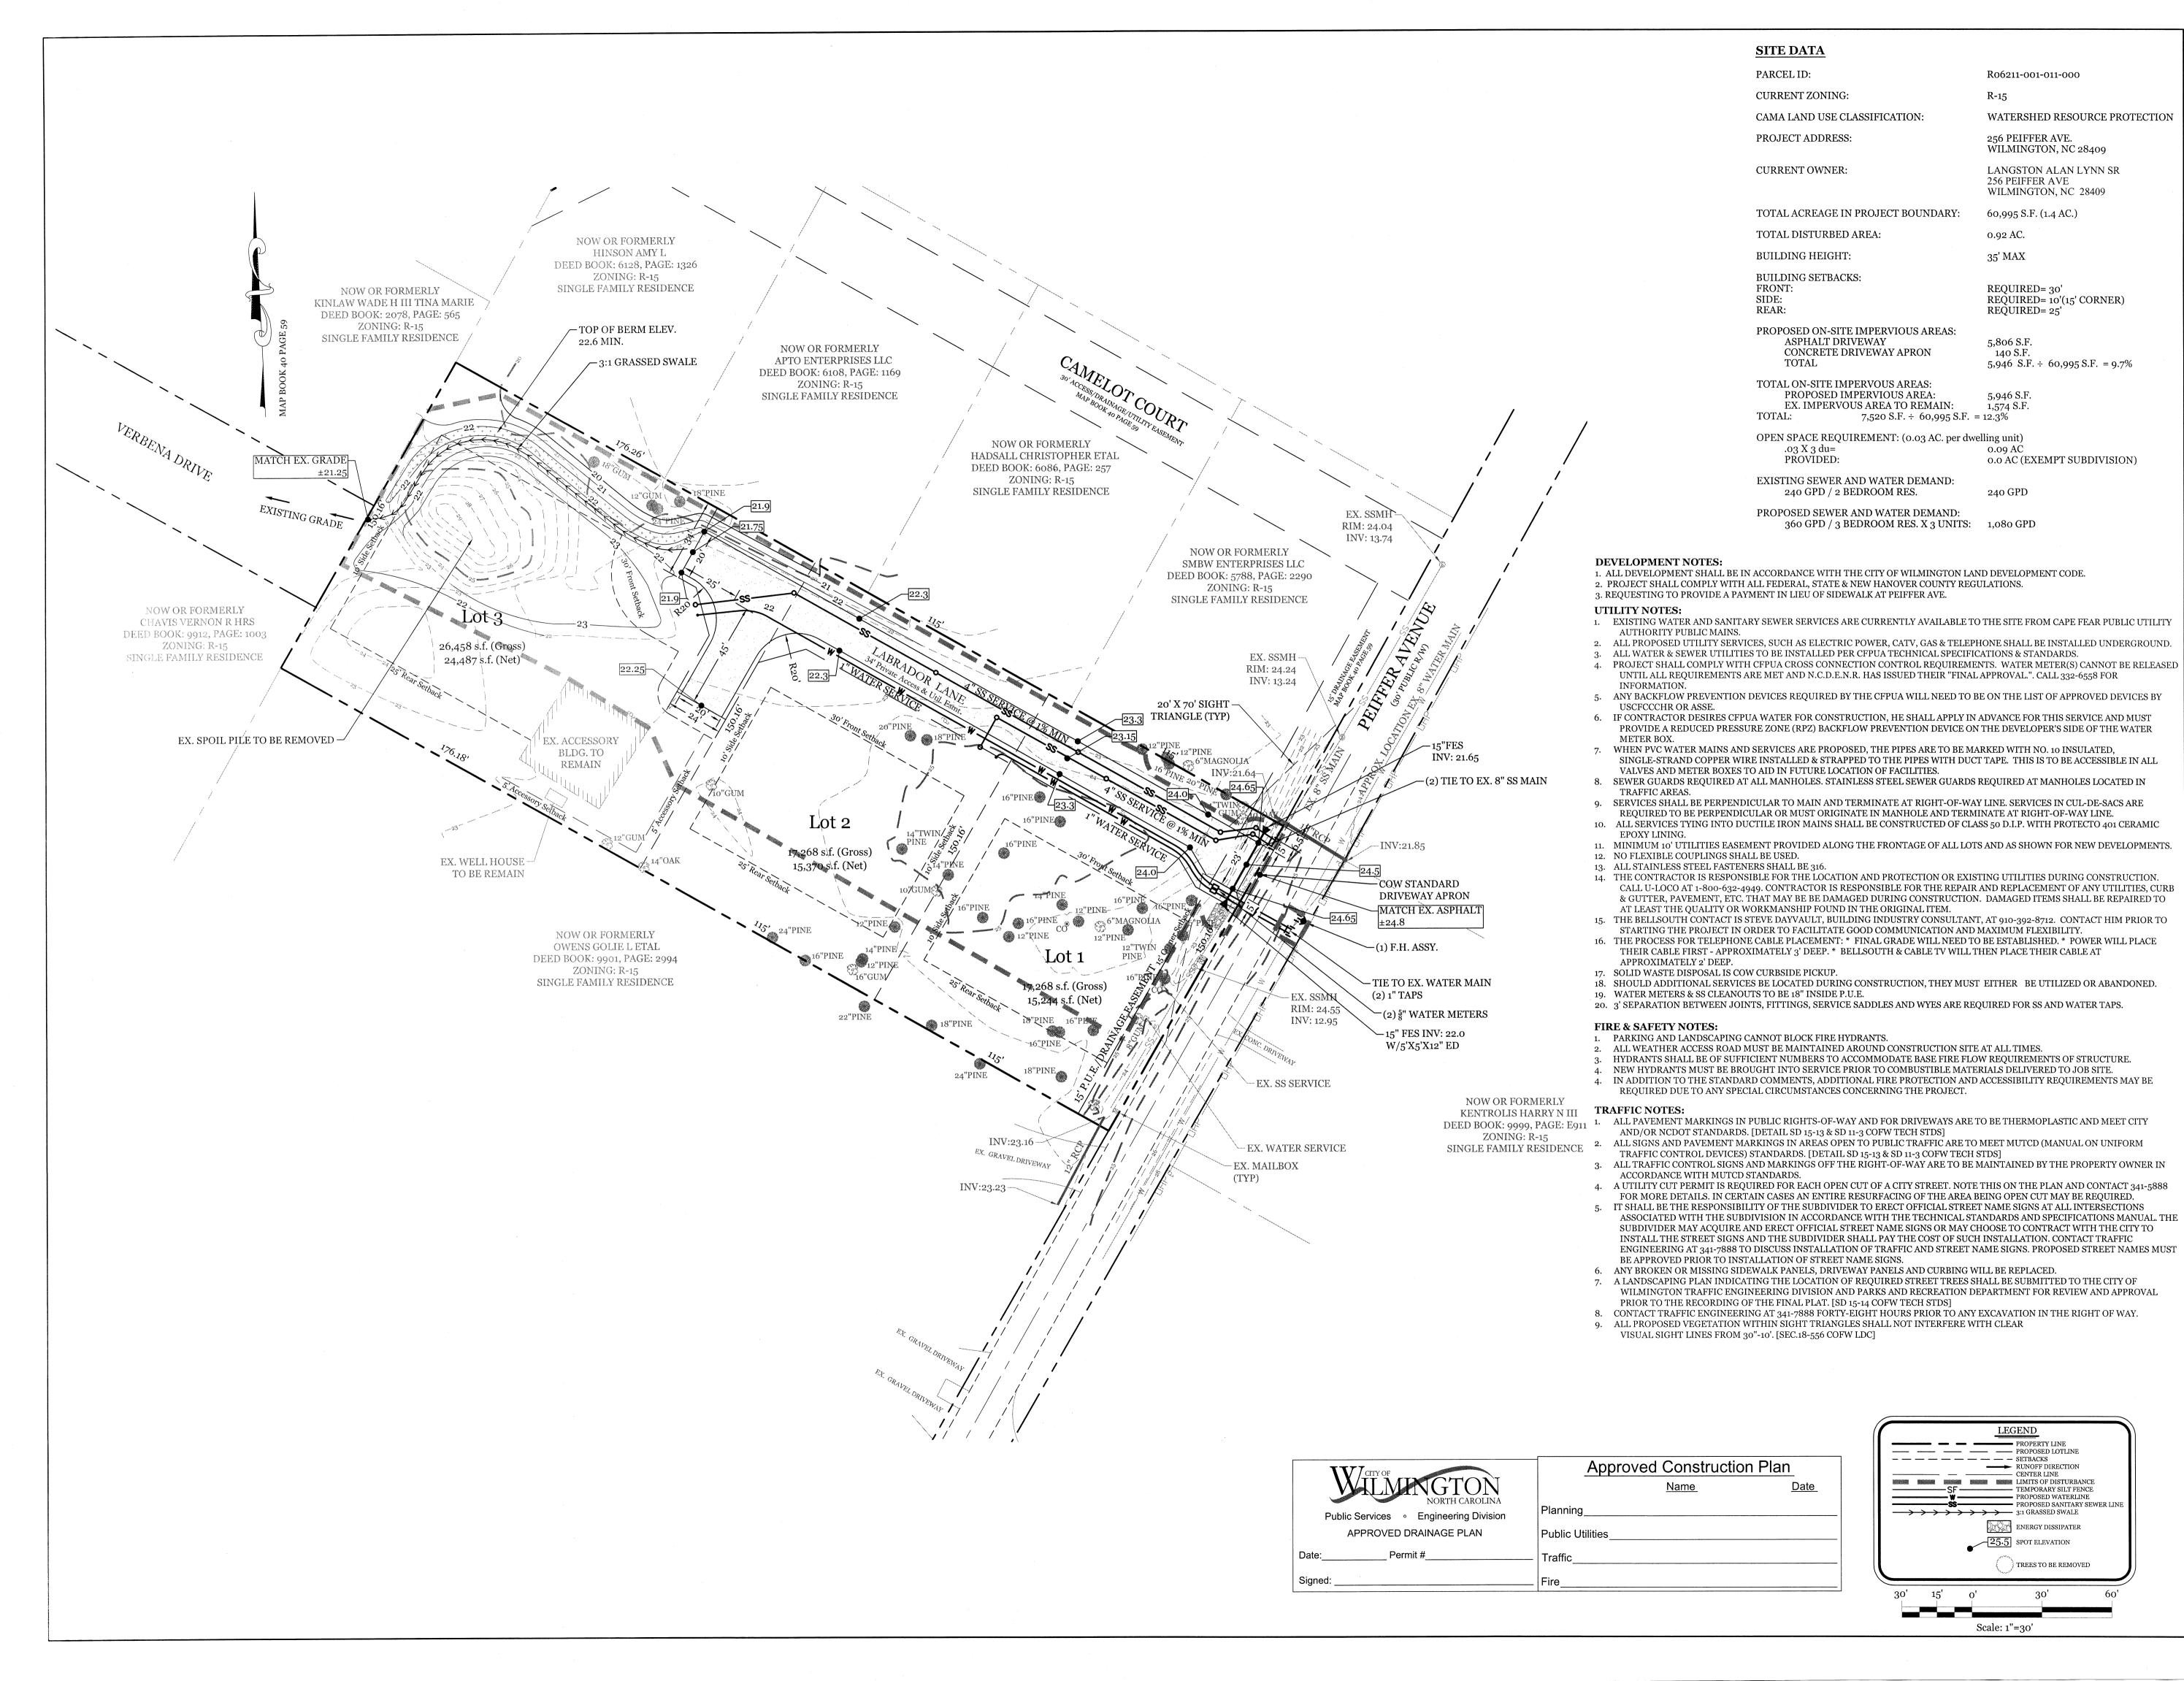

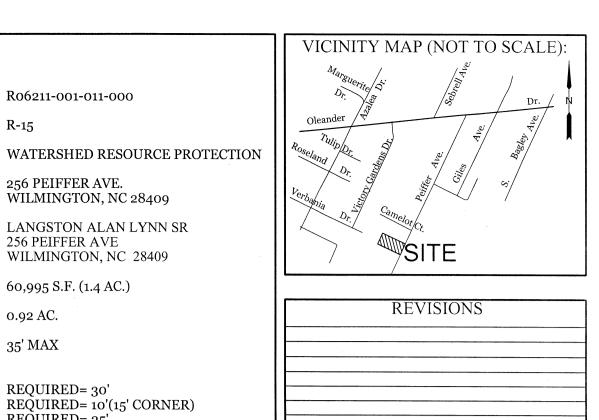

R06211-001-011-000

256 PEIFFER AVE.

256 PEIFFER AVE

60,995 S.F. (1.4 AC.)

REQUIRED= 30'

REQUIRED= 25'

0.92 AC.

35' MAX

5,806 S.F.

5,946 S.F.

1,574 S.F.

240 GPD

PROPERTY LINE

LIMITS OF DISTURBANCE

3:1 GRASSED SWALE

— — — — — — — — SETBACKS

—— PROPOSED LOTLINE

RUNOFF DIRECTION ---- CENTER LINE

PROPOSED WATERLINE

TREES TO BE REMOVED

ENERGY DISSIPATER

25.5 SPOT ELEVATION

Scale: 1"=30'

140 S.F.

WILMINGTON, NC 28409

WILMINGTON, NC 28409

LANGSTON ALAN LYNN SR

REQUIRED= 10'(15' CORNER)

5,946 S.F. ÷ 60,995 S.F. = 9.7%


o.o AC (EXEMPT SUBDIVISION)

CLIENT INFORMATION:


Seagate Landing, LLC Stephen Conway 6252 Towles Road Wilmington, NC 28409 Phone: 910-538-9737

| DRAWN: | JAE | SHEET SIZE: | 24x36 |
|-----------------|-----|-------------|----------|
| CHECKED: | CDC | DATE: | 8/8/2018 |
| APPROVED: | CDC | SCALE: | 1" = 30' |
| PROJECT NUMBER: | | 2018-023 | |

DRAWING NUMBER:

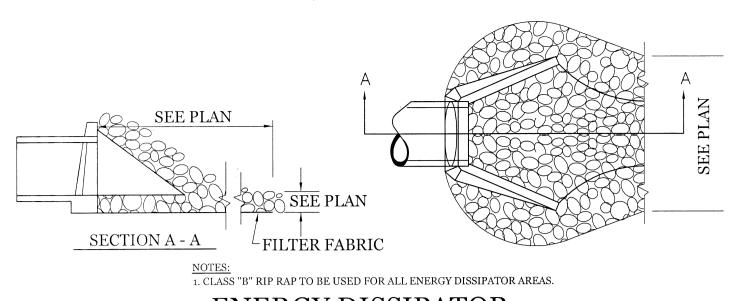


ENERGY DISSIPATOR

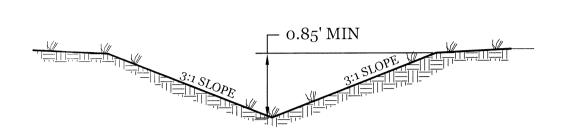

SEEDED IN ACCORDANCE WITH SPECIFICATIONS TYPICAL 3:1 GRASS SWALE

1. SWALES TO BE LINED WITH EXCELSIOR MAT &

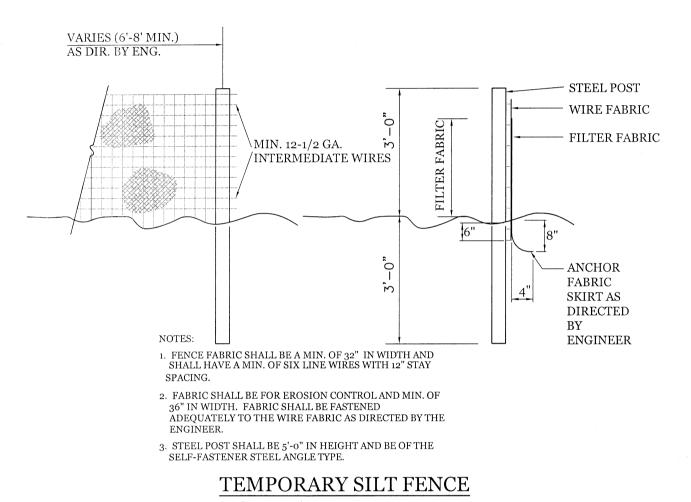

STANDARD DETAIL

RESIDENTIAL DRIVEWAY

PLAN


(VERTICAL CURB)

DATE: JUNE 1, 2015

DRAWN BY JSR

CHECKED BY D.E.C., P.E.

SCALE NOT TO SCALE

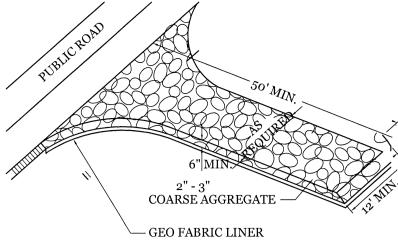

NOTE: CONSTRUCTION ENTRANCE TO BE 12' OR ENTIRE WIDTH OF ENTRANCE. WHICHEVER IS GREATER. TEMPORARY GRAVEL CONSTRUCTION ENTRANCE

SD 3-03.2

STANDARD DETAIL

RESIDENTIAL DRIVEWAY


CHECKED BY D.E.C., P.E.

SCALE NOT TO SCALE


SD 3-03.1

SECTIONS

(VERTICAL CURB)

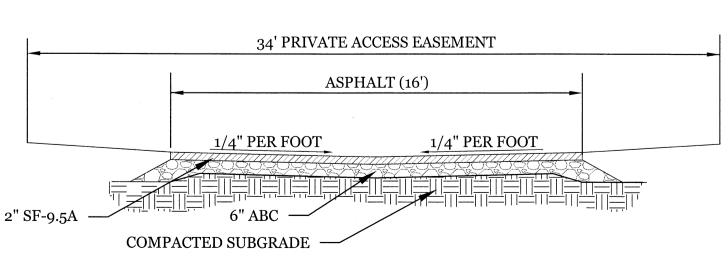

34' PRIVATE EASEMENT DRIVEWAY SECTION

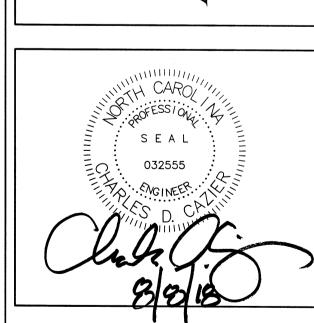

CLIENT INFORMATION:

Wilmington, NC 28409 Phone: 910-538-9737

Public Services

Engineering Division

APPROVED DRAINAGE PLAN

Approved Construction Plan

Public Utilities

JAE | SHEET SIZE: CDC DATE: CHECKED: 8/8/2018 APPROVED: CDC | SCALE: NTS PROJECT NUMBER: 2018-023

DRAWING NUMBER:

VICINITY MAP (NOT TO SCALE):

REVISIONS

Seagate Landing, LLC Stephen Conway 6252 Towles Road

C-2

SITE WORK NOTES:

DESIGNATED TO REMAIN.

REMOVAL OF ANY SOFT AREAS.

PROPERLY PERMITTED FACILITY.

1. THE CONTRACTOR SHALL VISIT THE SITE AND BECOME FAMILIAR WITH EXISTING CONDITIONS BOTH ON AND ADJACENT TO THE

2. CLEARING: CONTRACTOR SHALL REMOVE ALL TREES AND VEGETATION WITHIN LIMITS OF CONSTRUCTION UNLESS OTHERWISE

STRUCTURES ABOVE AND BELOW GRADE, ORGANIC MATERIAL OR ANY OTHER UNSUITABLE MATERIAL WITHIN LIMITS OF

4. MUCKING: CONTRACTOR SHALL COORDINATE WITH OWNER AND THEIR GEOTECHNICAL REPRESENTATIVE TO COORDINATE

7. THE CONTRACTOR SHALL NOTE THAT THE GRADING PLAN MAY NOT REPRESENT A BALANCED EARTHWORK CONDITION. THE CONTRACTOR SHALL BE RESPONSIBLE FOR CUT AND FILL QUANTITIES AND COMPLETE INSTALLATION TO SPECIFIED GRADES.

10. NO CONSTRUCTION IS TO BEGIN BEFORE LOCATION OF EXISTING UTILITIES HAS BEEN DETERMINED. CALL "NC ONE-CALL" AT

11. THE CONTRACTOR IS RESPONSIBLE FOR THE LOCATION AND PROTECTION OF ALL EXISTING UTILITIES DURING CONSTRUCTION. BEFORE COMMENCING ANY EXCAVATIONS IN OR ALONG ROADWAYS OR RIGHT-OF-WAYS, PUBLIC AREAS OR IN PRIVATE

12. THE CONTRACTOR SHALL BE RESPONSIBLE TO COORDINATE DISCONNECTION/ RECONNECTION AND/OR THE RELOCATION OF ALL

13. CONTRACTOR SHALL ADJUST ALL MANHOLES, VALVE & CURB BOXES TO FINAL GRADE UPON COMPLETION OF ALL CONSTRUCTION.

ANY BOXES DAMAGED OR OTHERWISE DISTURBED BY THE CONTRACTOR SHALL BE REPAIRED AT THE EXPENSE OF THE

15. THE CONTRACTOR SHALL FIELD VERIFY ALL DIMENSIONS AT THE SITE. FURTHERMORE THE CONTRACTOR SHALL REPORT ALL

17. ALL SERVICE CONNECTIONS SHALL BE INSTALLED TO MEET ALL LOCAL, STATE, AND CFPUA CODES. METERS, TAPS, MATERIALS, WORKMANSHIP AND ALL FEES SHALL BE THE RESPONSIBILITY OF THE CONTRACTOR AND SHALL COMPLY WITH ALL

19. ALL AREAS SHALL BE GRADED FOR POSITIVE DRAINAGE. CONTRACTOR SHALL REPORT ANY DISCREPANCIES TO THE ENGINEER

22. ALL SIDEWALKS SHALL BE FREE OF CRACKS, BREAKS, OR ANY OTHER DEFECT PRIOR TO RECEIVING A CERTIFICATE OF OCCUPANCY.

18. ALL BACKFILL FROM UTILITY INSTALLATION MUST BE COMPACTED OR AMENDED TO PROVIDE TRAFFIC BEARING CAPACITY.

20. CONCRETE FOR WALKS, CURBS AND DRIVES SHALL HAVE A MINIMUM COMPRESSIVE STRENGTH OF 3000 PSI @ 28 DAYS - AIR

21. FIELD TESTING SHALL BE DONE BY AN INDEPENDENT TESTING LABORATORY PAID FOR BY THE OWNER. FURTHER TESTING

PRIOR TO INSTALLATION. ALL AREAS SHALL BE SLOPED TO DRAIN AWAY FROM BUILDINGS AT ALL TIMES.

16. THE CONTRACTOR SHALL PROVIDE ANY AND ALL LAYOUT REQUIRED TO CONSTRUCT HIS WORK UNLESS OTHERWISE DIRECTED BY

14. EXISTING SURVEYING PERFORMED BY MICHAEL UNDERWOOD and ASSOCIATES, PA Firm License #C-0615

DISCREPANCIES OR QUESTIONS TO THE ENGINEER PRIOR TO INSTALLATION.

REQUIRED DUE TO A FAILED TEST WILL BE PAID FOR BY THE CONTRACTOR.

GEOTECHNICAL ENGINEER TO BE CONSULTED AT CONTRACTORS COST AS NECESSARY.

EASEMENTS, THE CONTRACTOR SHALL NOTIFY ALL APPROPRIATE PERSONNEL OF THEIR INTENT TO EXCAVATE, IN WRITING, NOT

RESPONSIBILITY OF THE CONTRACTOR TO DETERMINE THE EXACT ELEVATIONS AND LOCATIONS OF ALL EXISTING UTILITIES AT

ALL CROSSINGS PRIOR TO COMMENCING TRENCH EXCAVATION. IF ACTUAL CLEARANCES ARE LESS THAN INDICATED ON PLAN, THE CONTRACTOR SHALL CONTACT THE DESIGN ENGINEER BEFORE PROCEEDING WITH CONSTRUCTION. ANY CONDITION DISCOVERED OR EXISTING THAT WOULD NECESSITATE A MODIFICATION OF THESE PLANS SHALL BE BROUGHT TO THE ATTENTION OF THE

8. THE CONTRACTOR SHALL FURNISH SUITABLE BORROW MATERIAL FROM AN OFF-SITE PROPERLY PERMITTED FACILITY AS

9. INFORMATION CONCERNING UNDERGROUND UTILITIES WAS OBTAINED FROM AVAILABLE RECORDS. IT SHALL BE THE

5. DISPOSAL: CLEARED, GRUBBED, STRIPPED OR OTHER WASTE MATERIAL SHALL BE REMOVED FROM SITE AND DISPOSED OF IN A

3. GRUBBING AND STRIPPING: CONTRACTOR SHALL RAKE AND REMOVE ROOTS, STUMPS, VEGETATION, DEBRIS, EXISTING

6. FILL AND COMPACTION SHOULD COMPLY WITH GEOTECHNICAL RECOMMENDATIONS.

DESIGN ENGINEER BEFORE PROCEEDING WITH CONSTRUCTION.

LEAST 48 HOURS BEFORE COMMENCING CONSTRUCTION.

EXISTING UTILITIES WITH APPROPRIATE PERSONNEL.

LESS THAN 10 DAYS PRIOR TO EXCAVATING.